


PHASE II of LANDSCAPE IMPROVEMENTS

MONTANA FISH, WILDLIFE AND PARKS REGION 6 HEADQUARTERS

Glasgow, MT

7079154

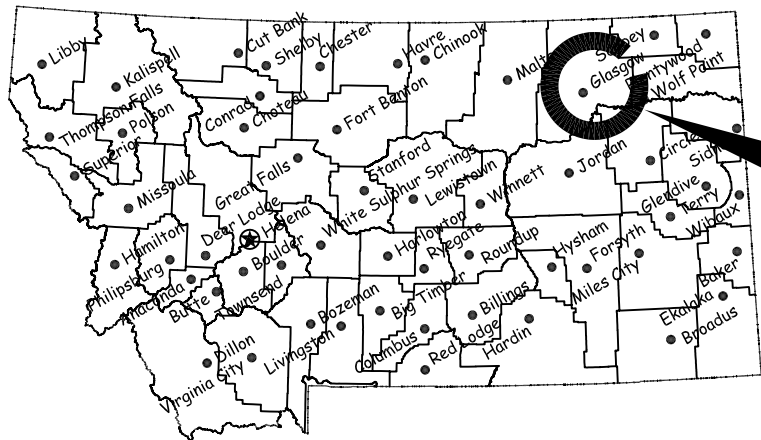

Project Location

Location Map

No Scale



Project Location

Vicinity Map

No Scale


MONTANA FISH, WILDLIFE AND PARKS
DESIGN AND CONSTRUCTION SECTION

MAILING ADDRESS: PO BOX 200701
HELENA, MT 59620-0701
TEL 406.841.4000
FAX 406.841.4004
fwp.mt.gov/Doing Business/Design&Construction

PHYSICAL ADDRESS: 600 NORTH PARK AVE.
HELENA, MT 59601

DRAWING INDEX

- 1 COVER SHEET
- 2 OVERALL SITE PLAN
- 3 PROJECT SITE PLAN - EAST PARKING LOT
- 4 WALL ELEVATIONS
- 5 RETAINING WALL SECTIONS
- 6 STAIR/RETAINING WALL SECTIONS
- 7 WALL AND LANDING DETAILS

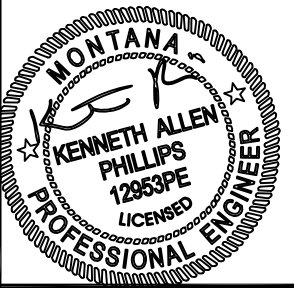

K. PHILLIPS March 13, 2013
DRAWN BY: DATE:
CHECKED BY: DATE:

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APPROVED BY: DATE:



**Montana Fish,
Wildlife & Parks**

Region 6 Headquarters
Landscape Improvements - Phase II

SHEET: 1 of 8

Wareyard and Storage Building

DO NOT BLOCK ALLEYWAY
STOCKPILE AREA WILL BE IN
WAYETARD

Main Project Area
See Sheet 3


Open Storage
Building

Quonset
Building

FWP Region 6
Headquarters

WALL LEGEND
CONCRETE STEM WALL W/ BLOCK CAP
BLOCK WALL W/ CAP

Airport Road

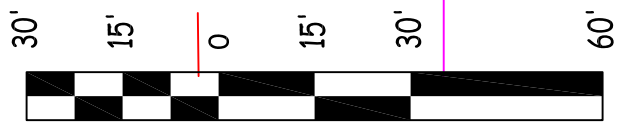

Overall Site Plan

SCALE : 1" = 30'




B. Mangum	3/27/2013
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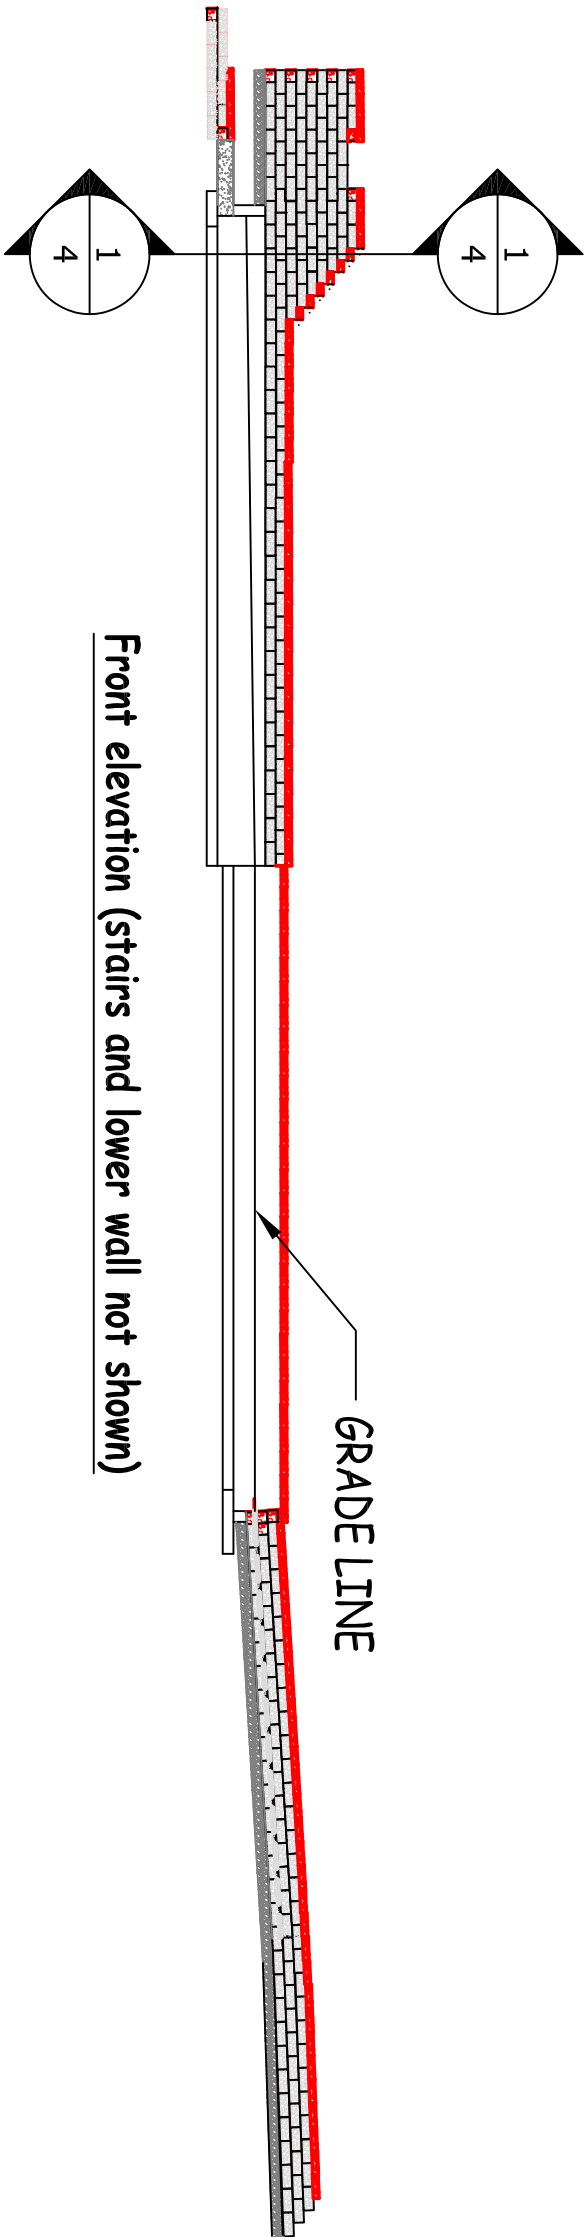
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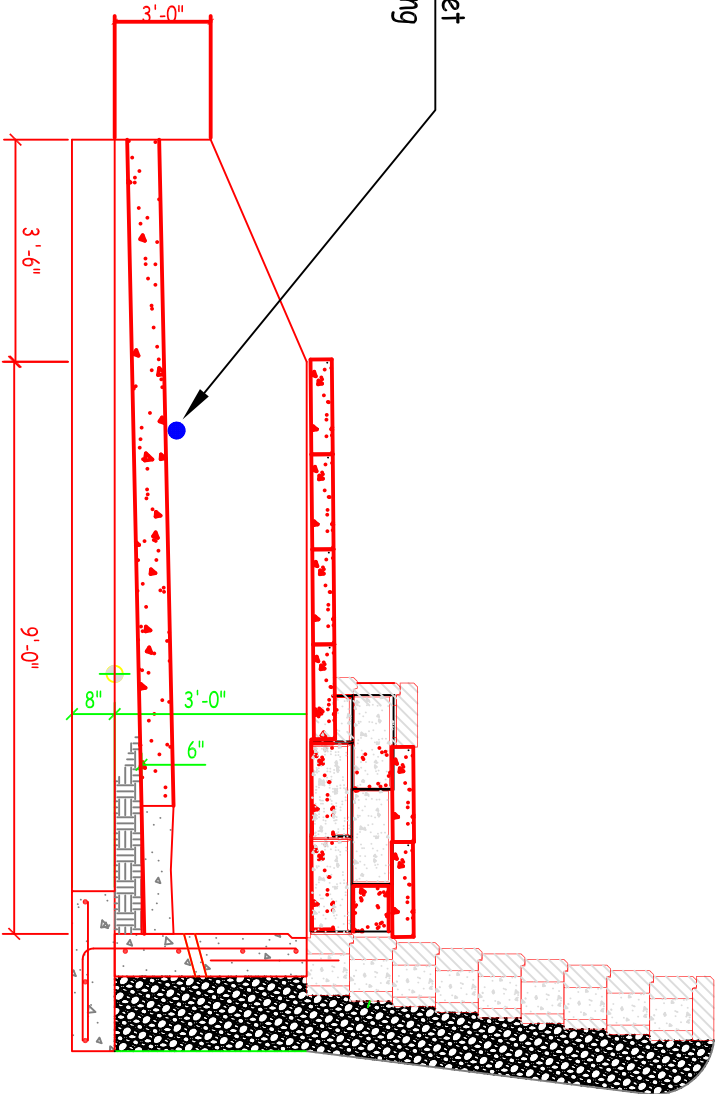


Region 6 Headquarters
Landscape Improvements - Phase II





Drain pipe outlet
with bird screening

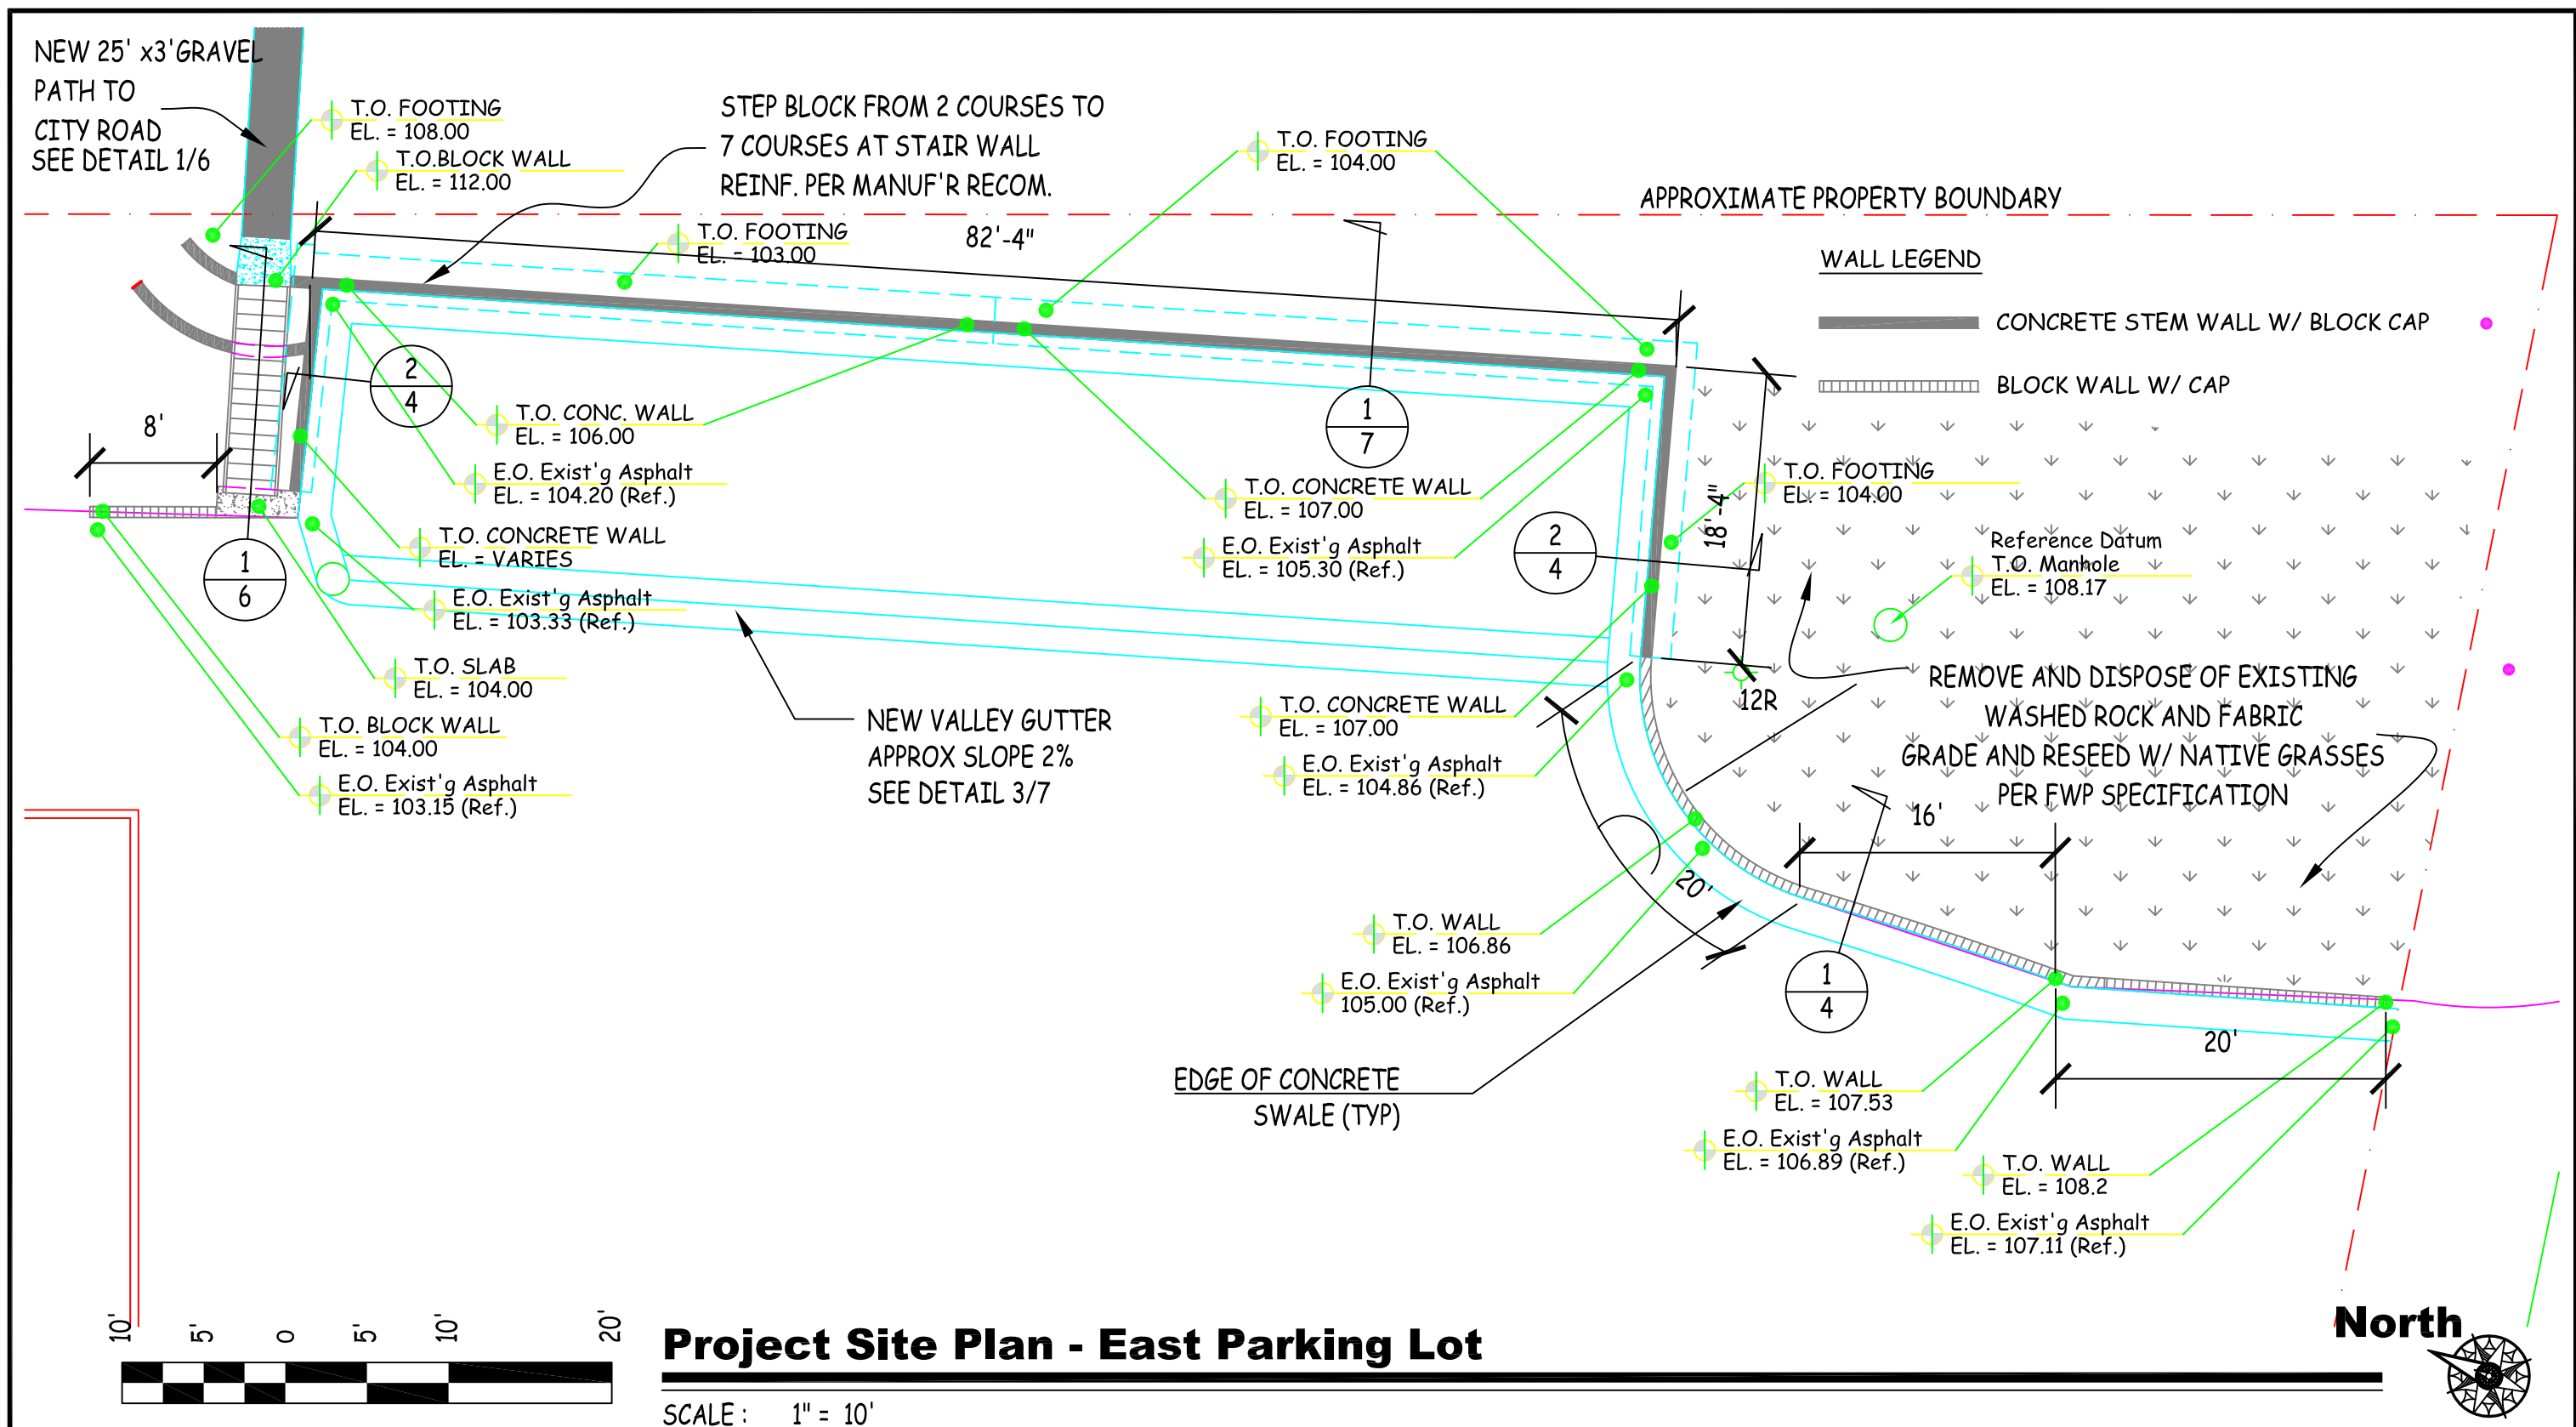

WING WALL ELEVATION

SCALE : 1" = 1'-0"

1
4

WING WALL NOTES

START UPPER TWO COURSES OF BLOCK AND CAP OF LOWER RETAINING WALL ON TOP OF WING WALL. ANCHOR FIRST BLOCK TO WALL WITH GROUTED REBAR DOWEL. THEN TRANSITION OFF OF WALL TO FORM LOWER WALL RADUIS. RUN CAP ON TOP OF REMAINING WING WALL TO THE START OF WALL TAPER. For more detail see sheet 8,

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BMangum	5/2013
CHECKED BY:	DATE:

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APPROVED BY:	DATE:


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Landscape Improvements-Phase II
Region 6 Headquarters

7079154


SHEET: 4
of 8



RETAINING WALL SECTION

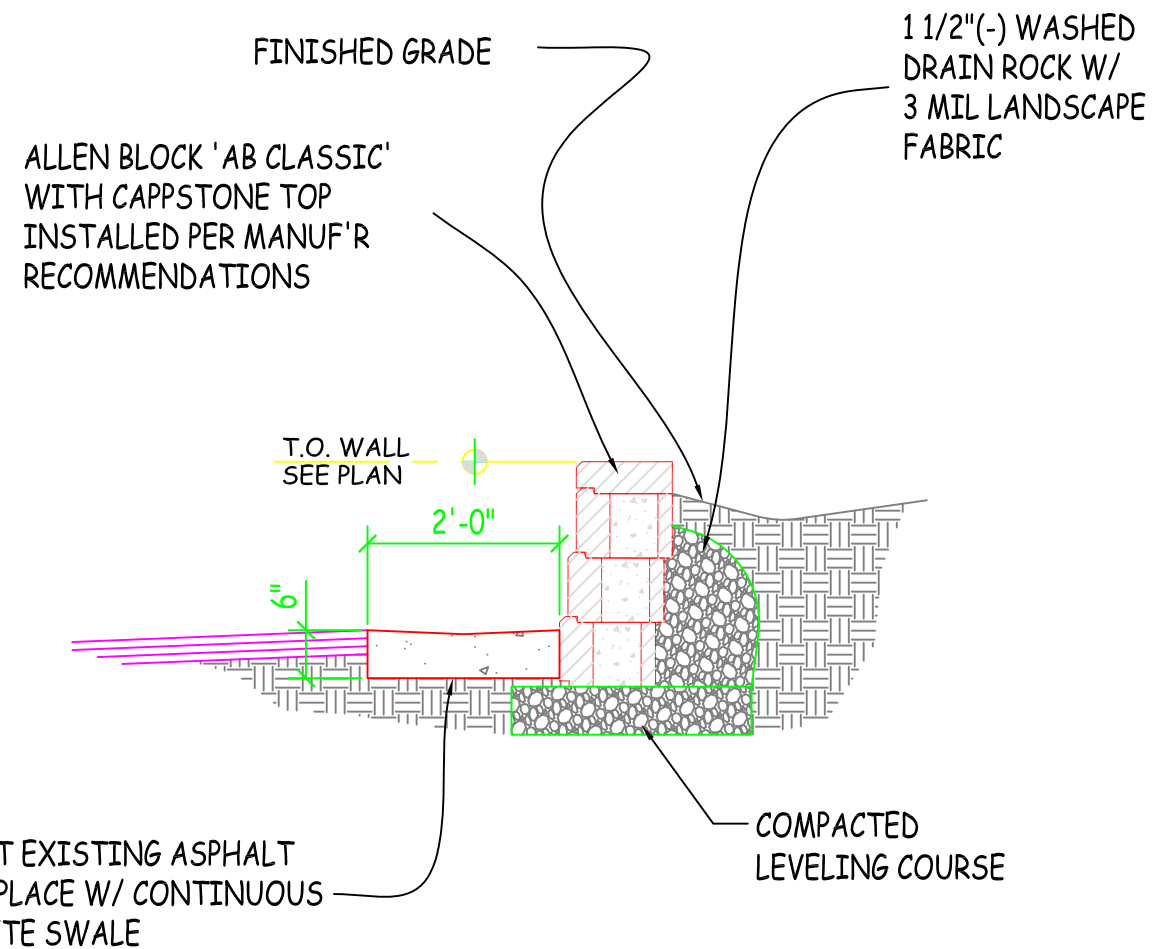SCALE : 1" = 1'-0"

1
4

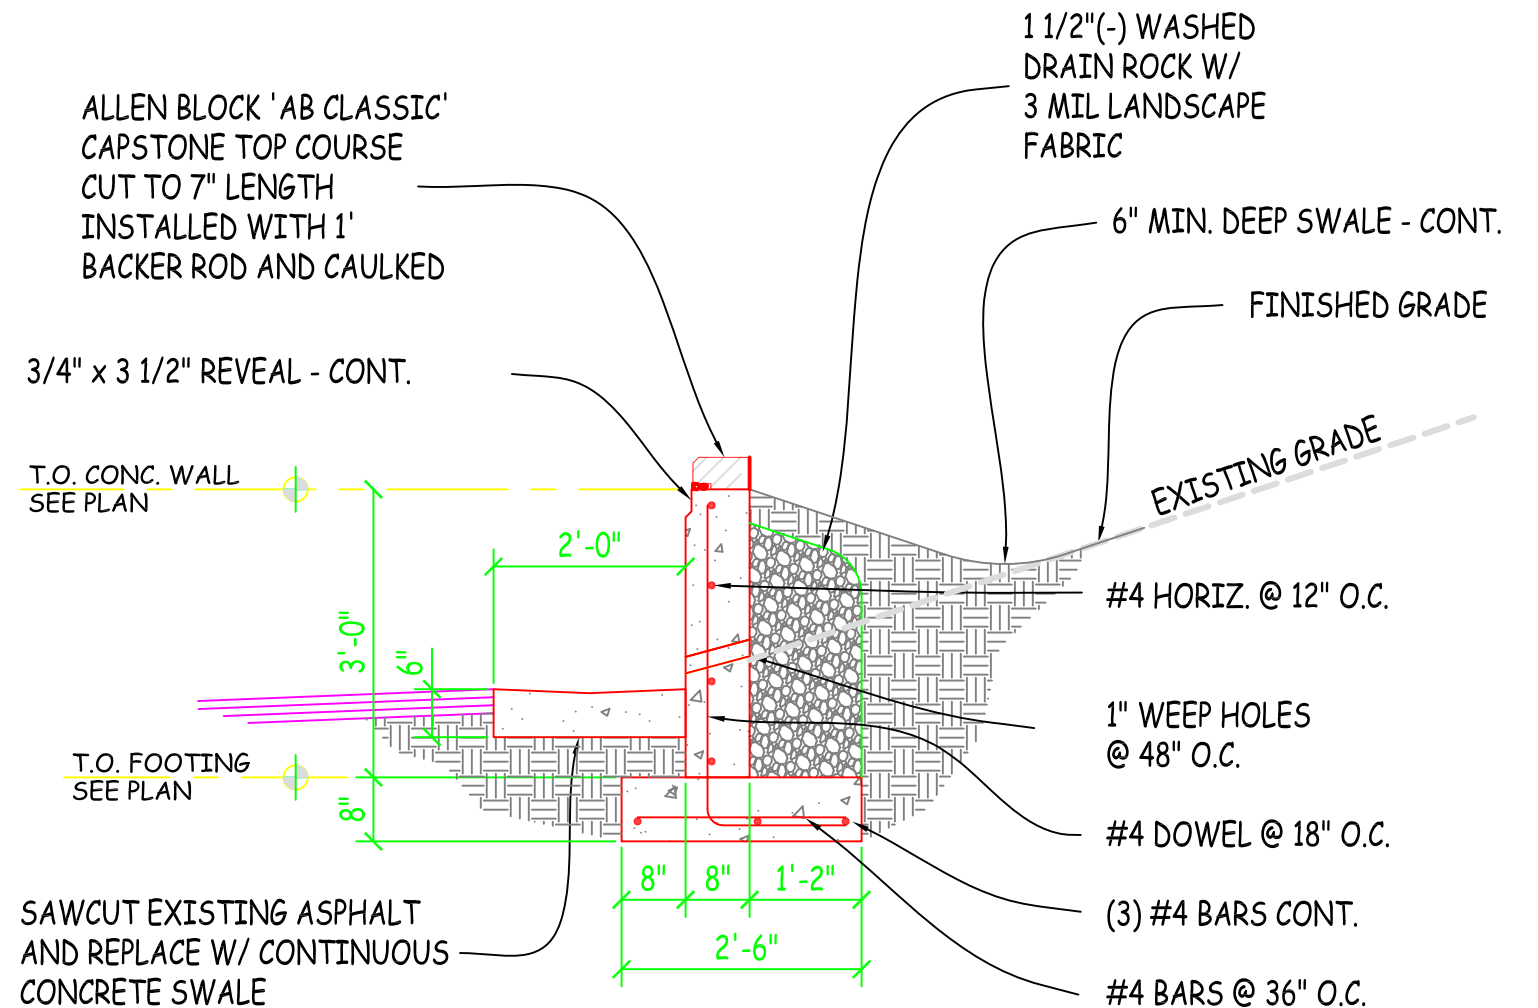

RETAINING WALL SECTION

SCALE : 1" = 1'-0"

2
4

B. Mangum 3/8/2013
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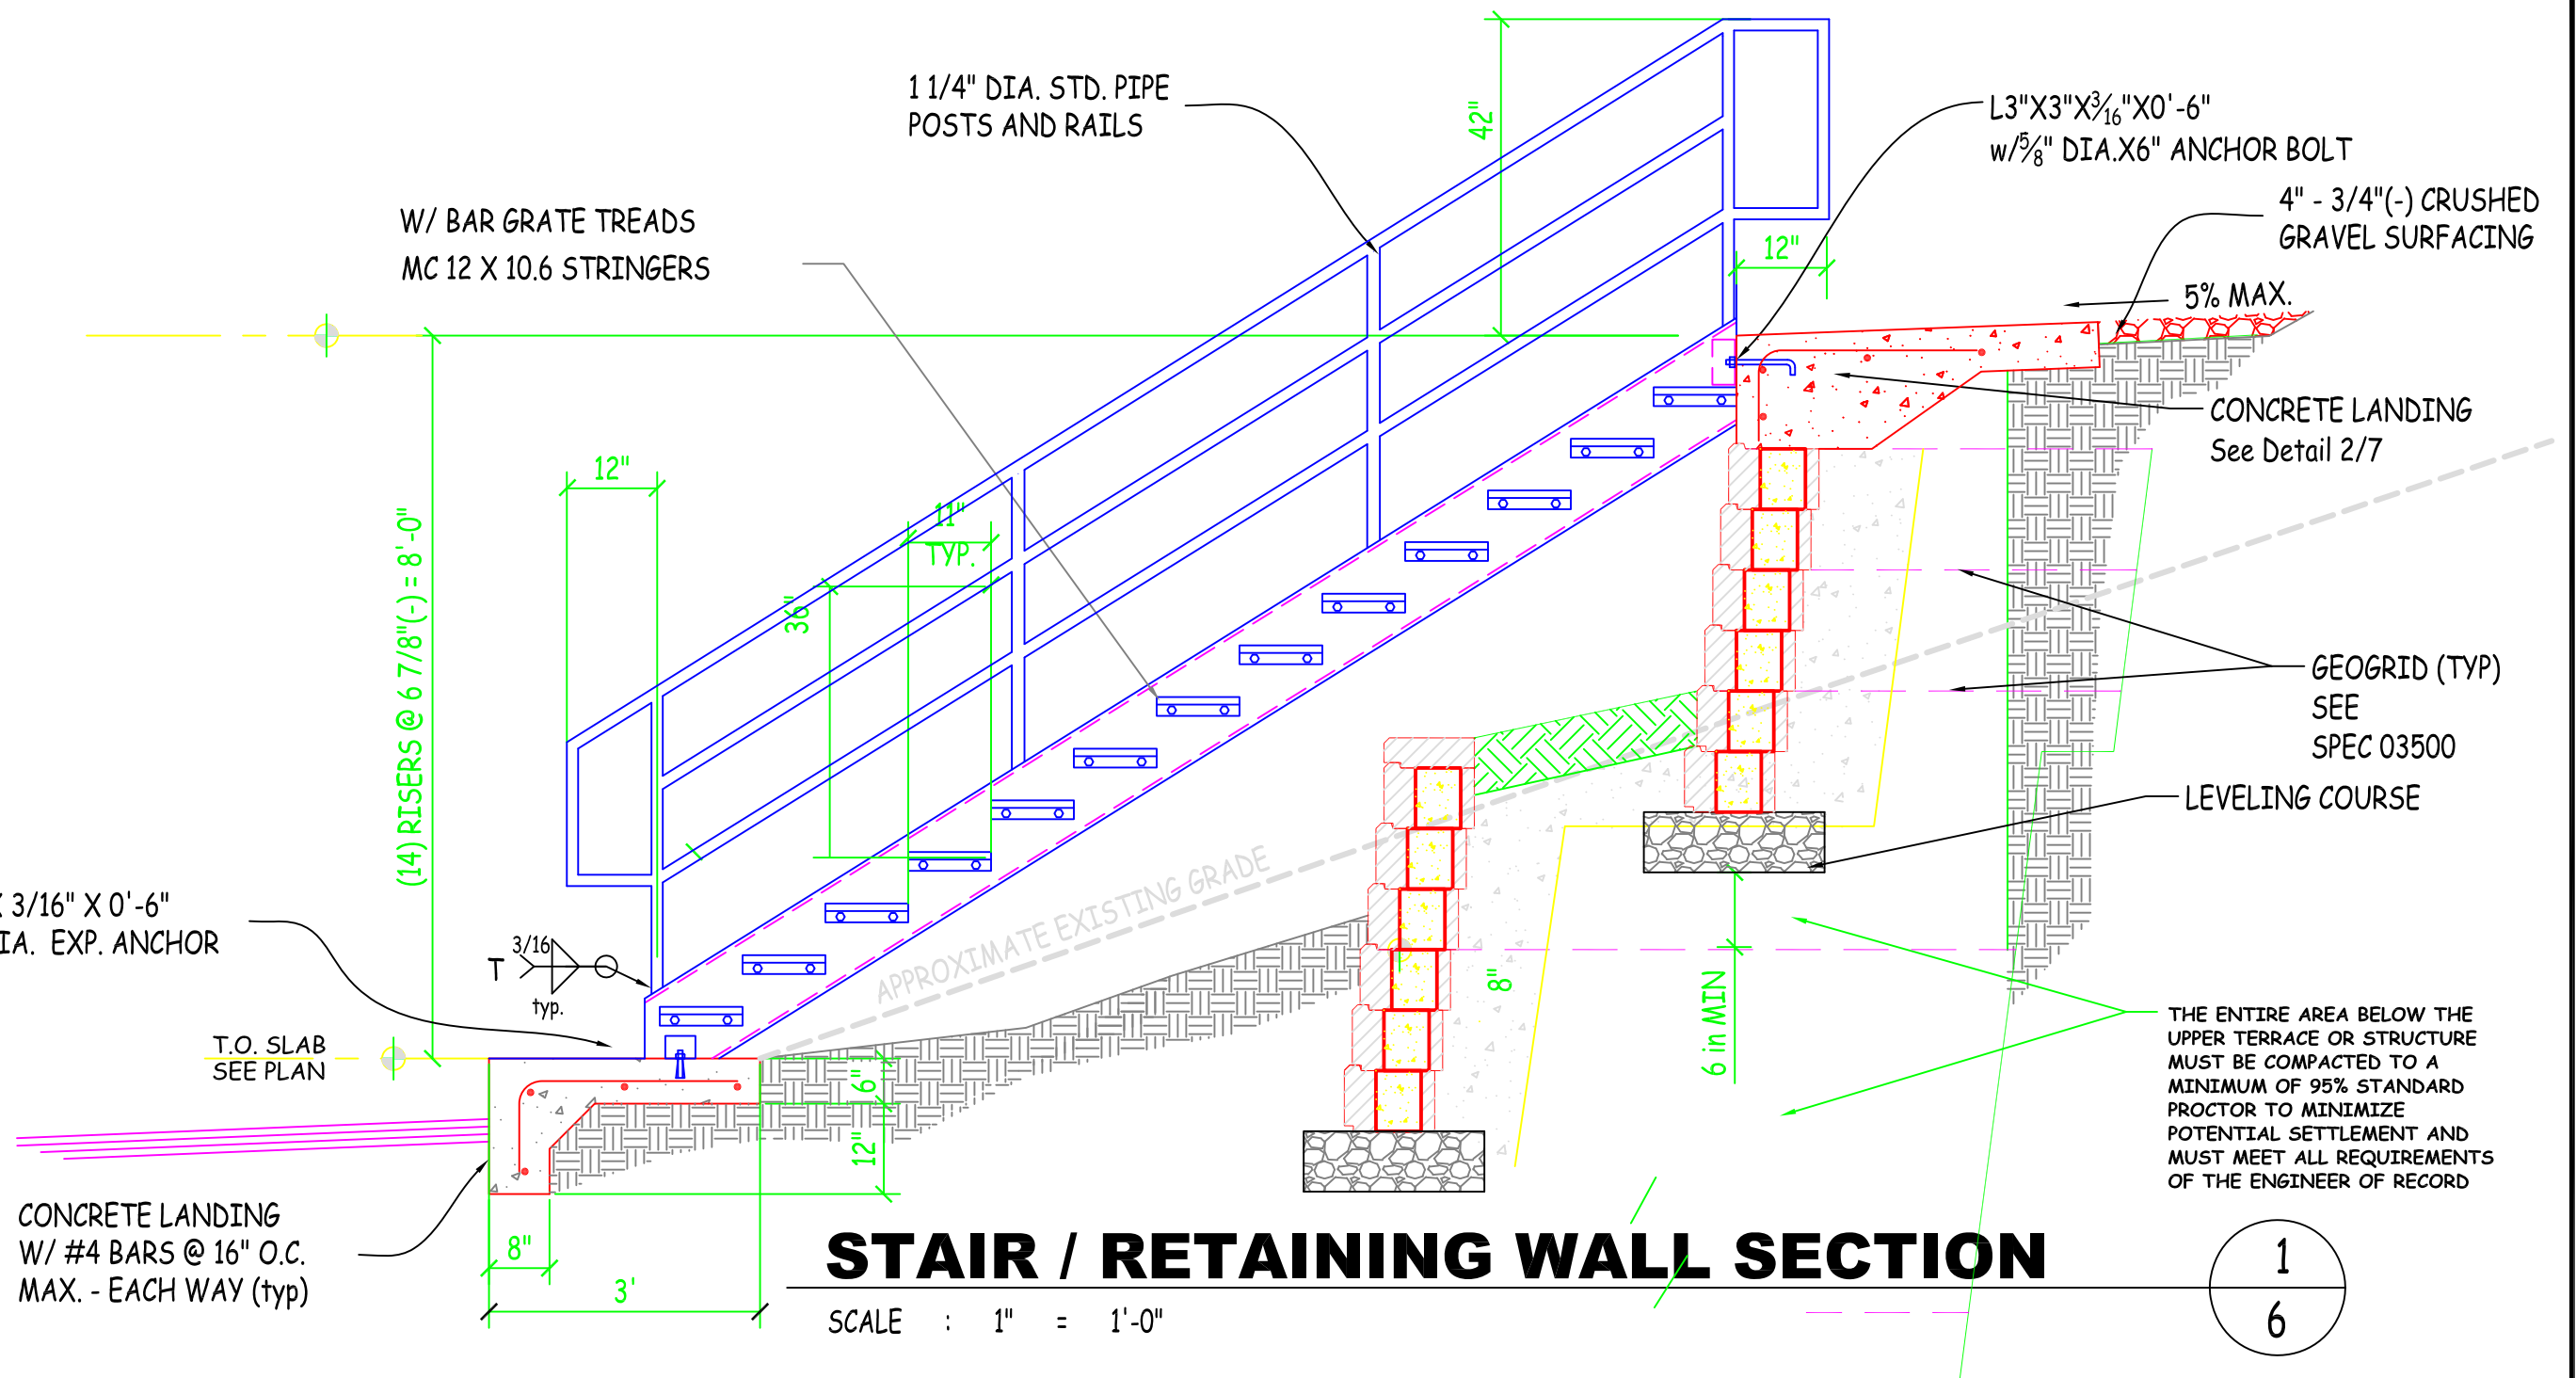


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SHEET: 5 of 8



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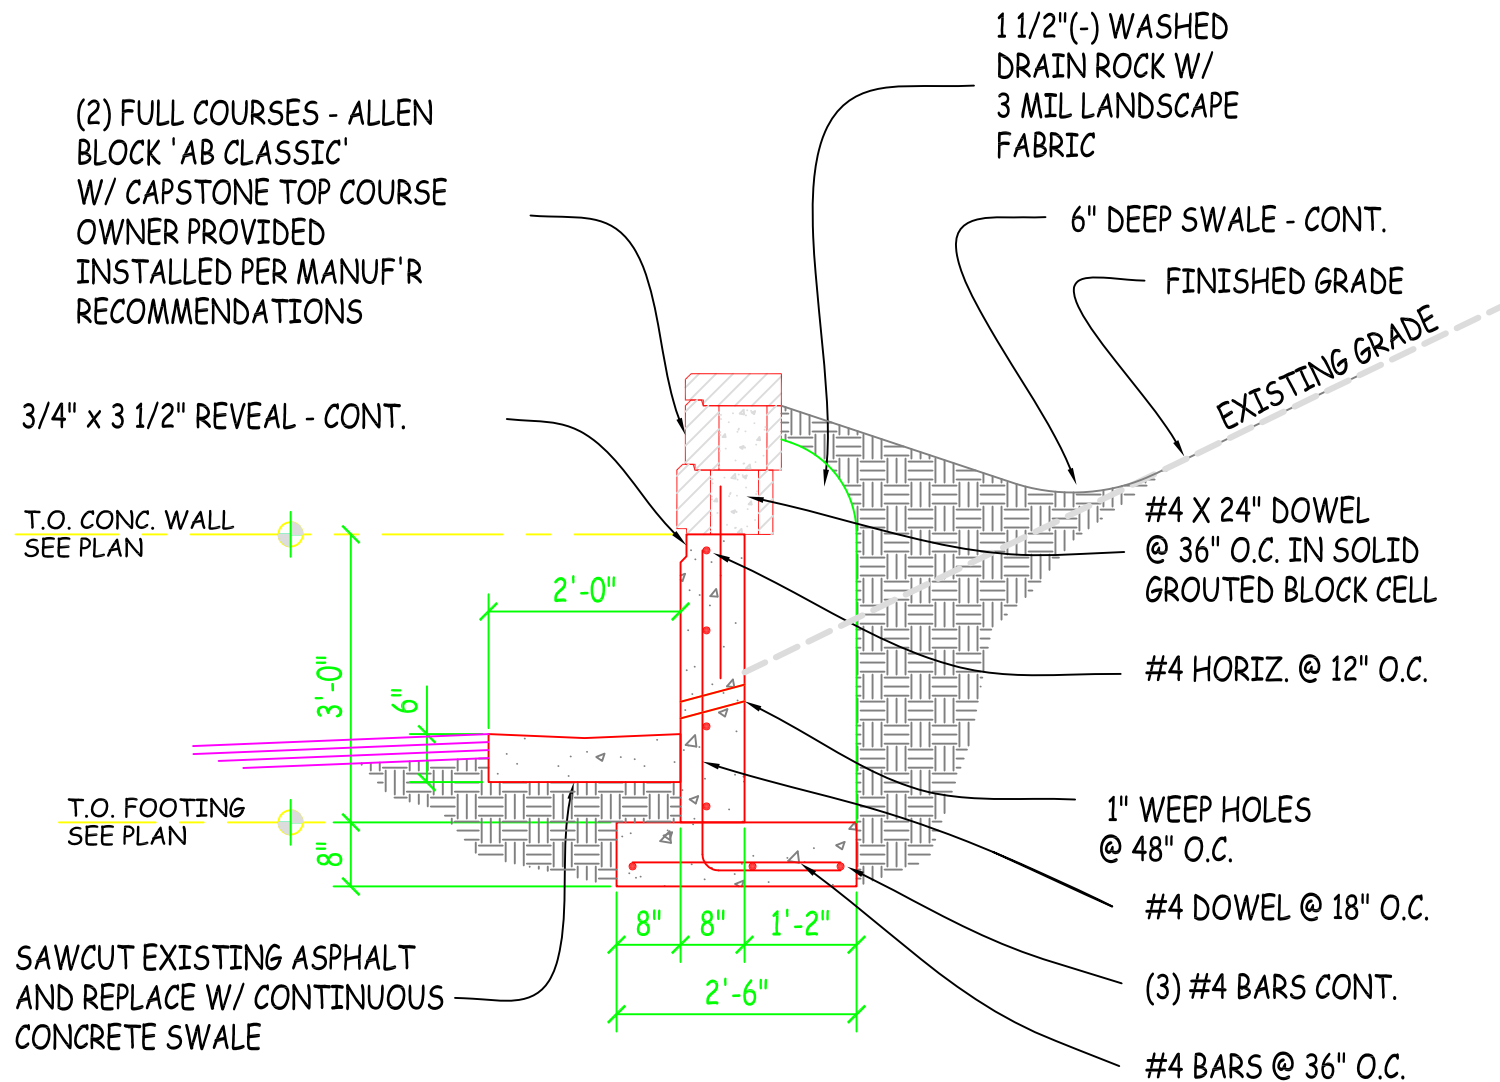


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SHEET: 6
of 8




RETAINING WALL SECTION

SCALE : 1" = 1'-0"

1

7

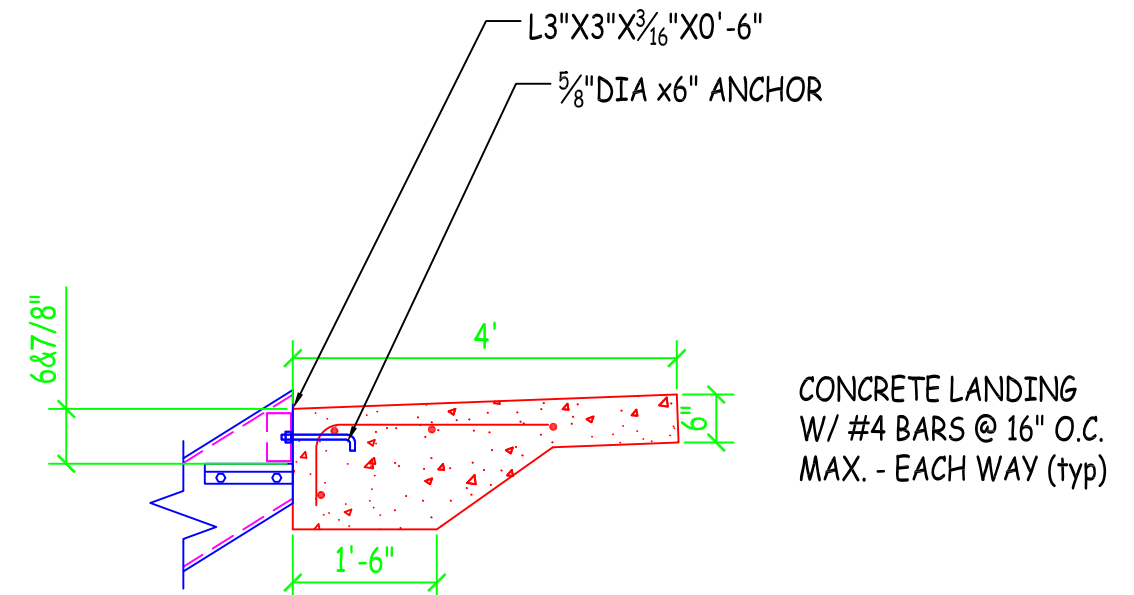


UPPER LANDING DETAIL

SCALE : 1" = 1'-0"

2

7

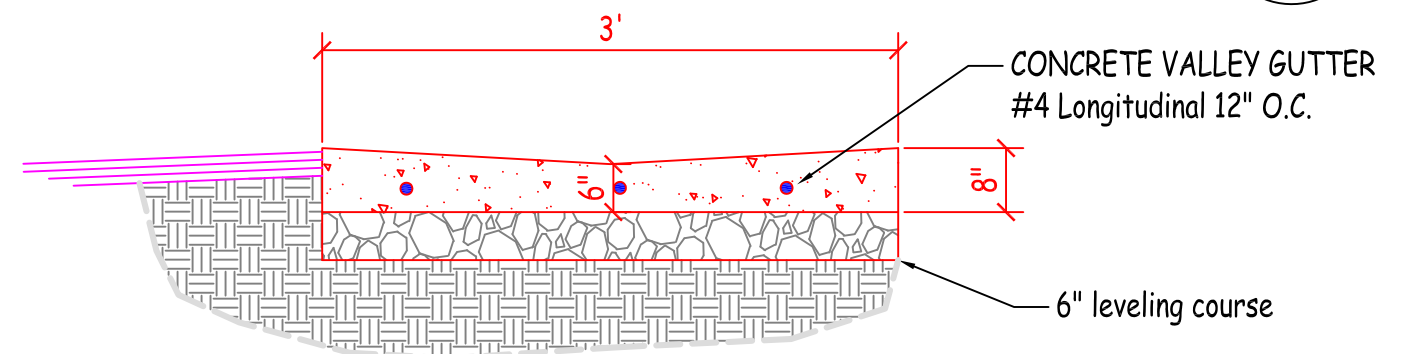

VALLEY GUTTER DETAIL

SCALE : 1" = 1'-0"

3

7

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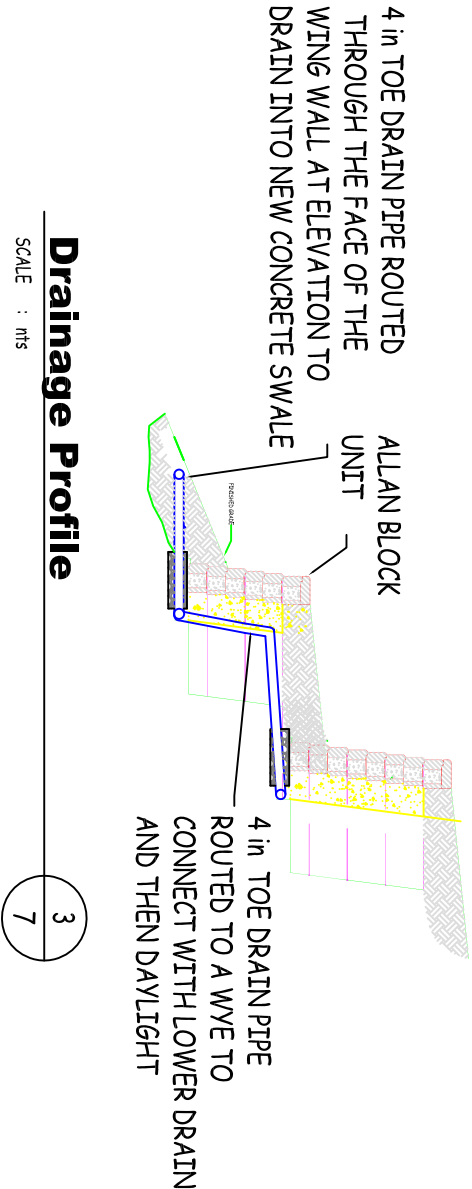


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SHEET: 7 of 8




Drainage Profile

SCALE : mts

3

7

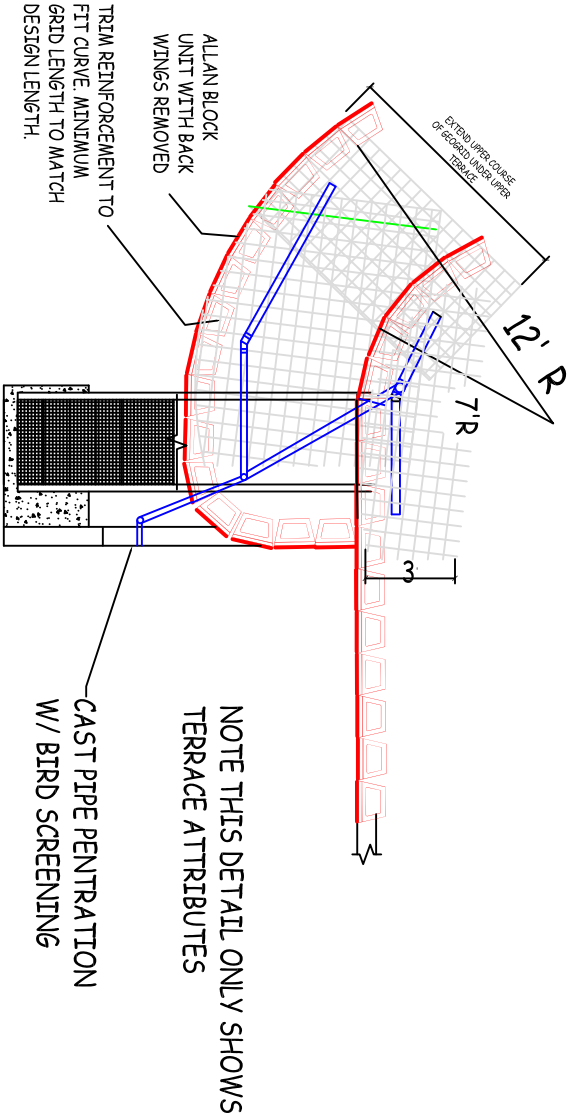


BLOCK TERRACE LAYOUT

SCALE : 1" = 5'-0"

1

8

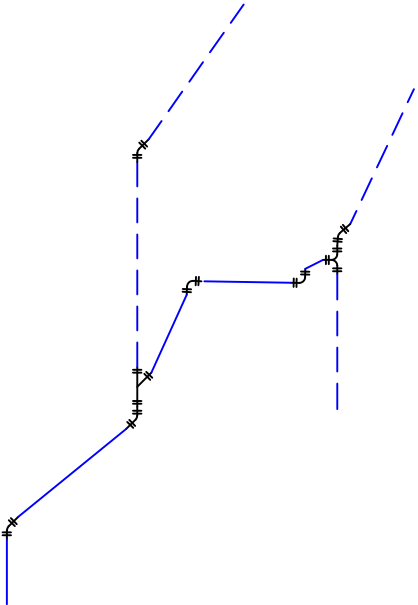

Drainage Isometric

SCALE : mts

3

7

NOTES:
ALL LATERALS TO BE 4" SCH 40 PERFORATED PIPE
ALL TRANSMISSION PIPING TO BE SOLID WALL SCHEDULE 40 PVC AS WELL AS ALL FITTINGS.
ALL PIPE TO HAVE A MINIMUM 2% SLOPE

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Landscape Improvements - Phase II